


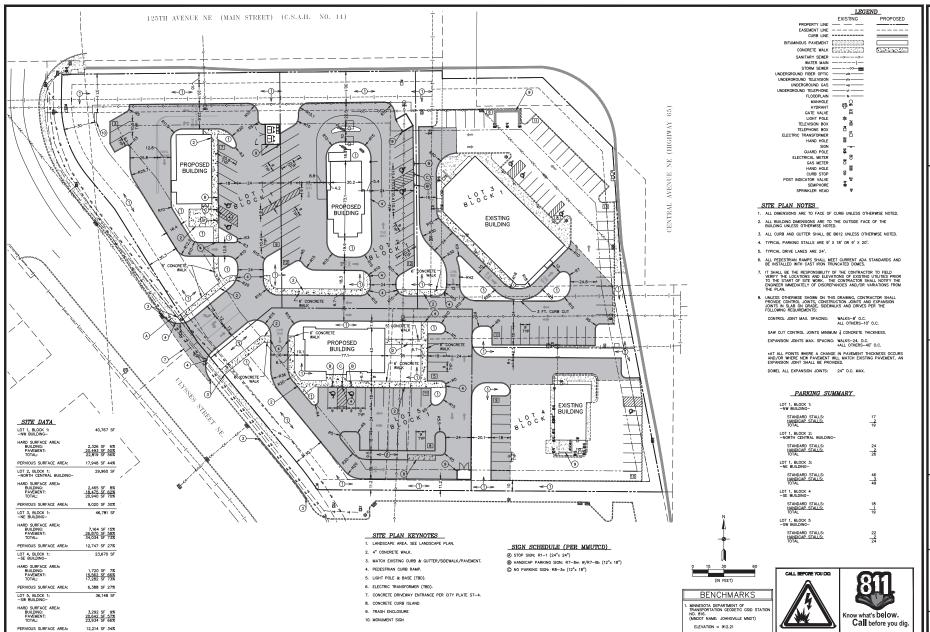

Case File No. 21-0023
Blaine Square 2nd Addition







PLAN

SITE

ADDITION


BLAINE SQUARE SECOND
Blaine, Minnesota


ESTATE, INC. reet, Suite 2630 MN 55402 CAPITAL P 60 South S Minnes


REVISIONS


ture: <u>4 T. P.</u>

5 13

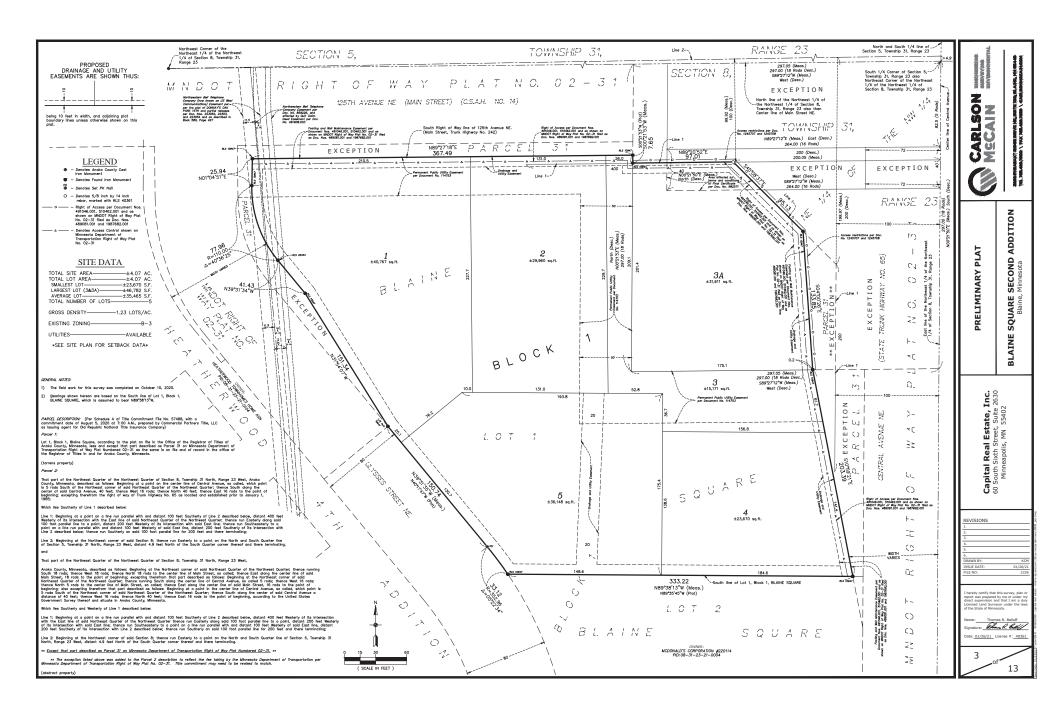

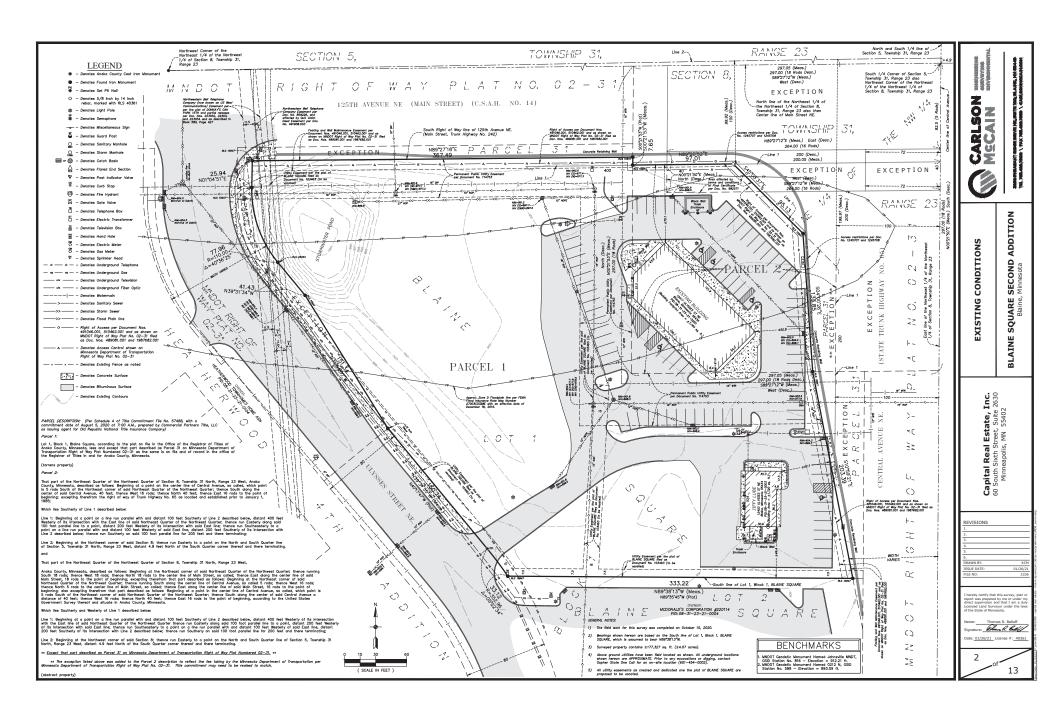

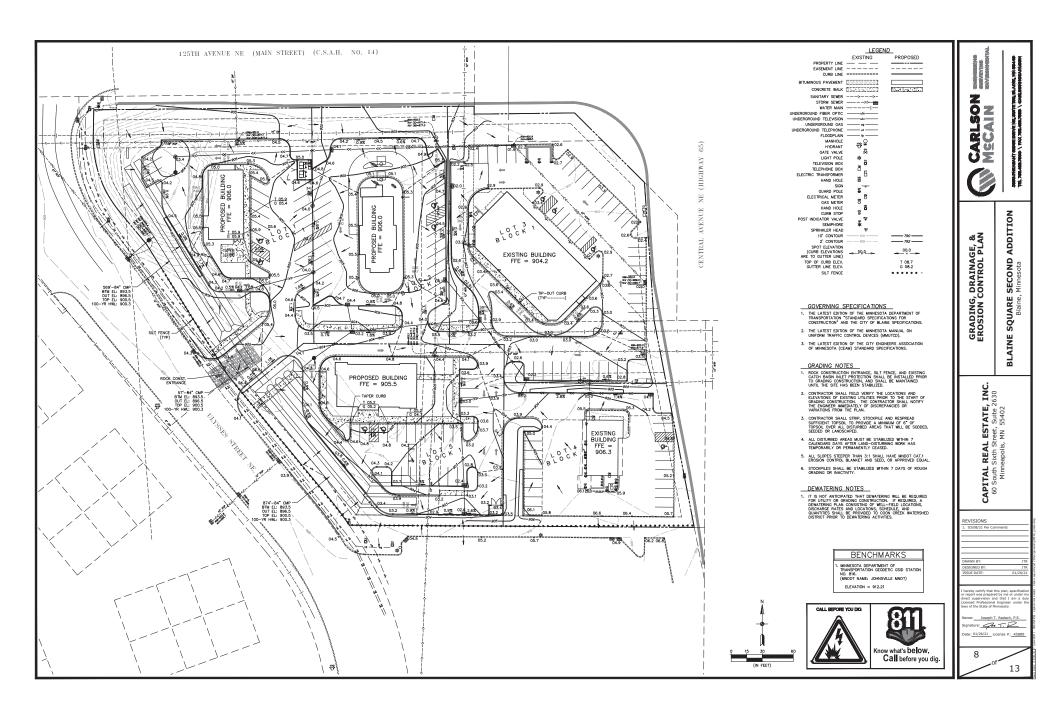

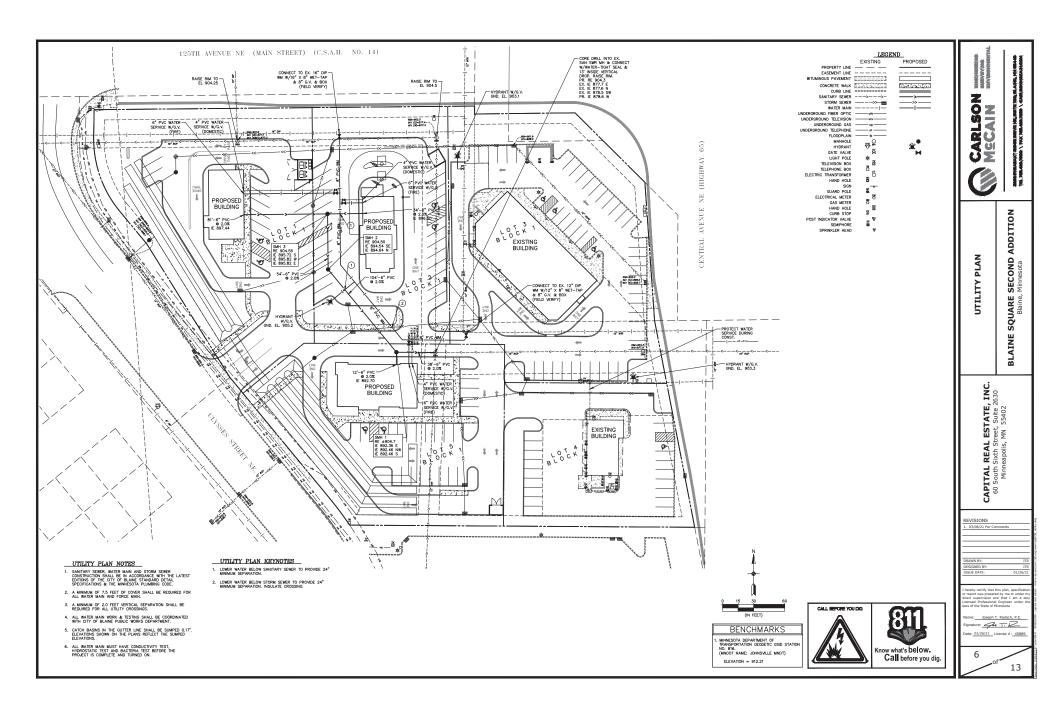

CONSTRUCTION STAGING AND ACCESS, CONTRACTOR SHALL VERFY THE LOCATION FOR CONSTRUCTION STAGING AND STE ACCESS With the OWNER/AMOSCAPE ARCHITECT PROPRIED TO CONSTRUCTION START, CONTRACTOR SHALL BE RESPONSIBLE FOR MAINTAINNEY PRESENTAIN AND VERTILES ACCESS WITHIN AND ALACONT TO THE STET INFOCUCION THE CONSTRUCTION FERRO UNLESS CHIERMES NOTICE. LONG-TERM STROKE OF MATERIALS OF SUPPLIES ON-STET WILL NOT BE FERRORITED, ALL MOSTE AND/OFF UNDESS AND STATE SHALL BE PROMITED, ALL MOSTE AND THE STEE.

MINMUM I/2 WOTH OF ROOT BA

B CONIFEROUS TREE PLANTING DETAIL

PLANTING BOIL MIXTURE (SEE SPEC -UNDISTURBED OR STABILIZED SUBSO!

CITY OF BLAINE LANDSCAPE REQUIREMENTS - ALL LOTS

- ONE (1) OVERSTORY DECIDIOUS SHADE TREE FOR EVERY TWO THOUSAND (2,000) SQUARE FEET OF TOTAL BUILDING FLOOR AREA OR ONE (1) TREE FOR EVERY ONE HUNDRED (100) FEET OF SITE PERIMETER, WHICHEVER IS GREATER.
- ONE (1) CONIFEROUS TREE FOR EVERY TWO THOUSAND (2,000) SQUARE FEET OF BUILDING OR ONE (1) CONIFEROUS TREE FOR EVERY TWO HUNDRED (200) FEET OF SITE PERIMETER, WHICHEVER IS GREATER.
- ONE (1) UNDERSTORY SHRUB FOR EVERY THREE HUNDRED (300) SQUARE FEET OF BUILDING OR ONE (1) SHRUB FOR EVERY THIRTY (30) FEET OF SITE PERIMETER, WHICHEVER IS GREATER.
- ONE (1) ORNAMENTAL TREE FOR EVERY TWO THOUSAND (2,000) SQUARE FEET OF BUILDING OR ONE (1) ORNAMENTAL TREE FOR EVERY TWO HUNDRED (200) FEET OF SITE PERIMETER, WHICHEVER IS GREATER.
- UNDERGROUND IRRIGATION SHALL BE REQUIRED FOR ALL LANDSCAPE AREAS. SUCH IRRIGATION SHALL EXTEND TO INCLUDE PUBLIC BOULEVARDS AND INTO LANDSCAPED PARKING ISLANDS, EXCEPT NATURAL AREAS TO BE PRESERVED.

BEQUIED PER 32.54 = 4 OVERSTORY TREES (AUXIS OF BUILDING / 2000 = 2, OR 841 LF STE FEMILIER / 100 = 8) TOTAL REQUIED = 12 OVERSTORY TREES (AUXIS OF BUILDING / 2000 = 2, OR 841 LF STE FEMILIER / 100 = 8) TOTAL REQUIED = 12 OVERSTORY TREES

FEROUS TREES.

COMPETIONS TREES (2.326 SF BUILDING / 2000 = 2, OR 841 LF SITE PSAULET P / 200 = 4)

COMPETIONS TREES (2.326 = 2 COMPETIONS TREES (ADDITIONAL - 1.5X WITHIN HWY 65 OVERLAY DISTRICT)

TOTAL REQUIRED = 6 COMPETIONS TREES

3. UNDERSTORY SHRUES.

SEQUED PER 3.25.4 = 28 UNDERSTORY SHRUES (2.326 SF BUILDING / 300 = 8, OR 841 LF STE FEOMETER / 30 = 28)

EXCURSION DER 3.25.4 = 14 LINCRISTORY SHRUES (4.00TROML - 1.5X WITHIN HIY 65 OVERLAY DISTRICT) IDIAL REQUESTED = 40 LINCRISTORY SHRUES (4.00TROML - 1.5X WITHIN HIY 65 OVERLAY DISTRICT) IDIAL REQUESTED = 40 LINCRISTORY SHRUES

4. ORNAMENTAL TREES. (2,126 SF BUILDING / 2000 = 2, OR 841 LF STE FRAMETER / 200 = 4)

BEQUIRED FER 32.54 = 2 ORNAMENTAL TREES (2,126 SF BUILDING / 2000 = 2, OR 841 LF STE FRAMETER / 200 = 4)

BEQUIRED FER 32.54 = 2 ORNAMENTAL TREES (ADDITIONAL - 1.5X WITHIN HWY 65 OVERLAY DISTRICT)

SIGNET (MEZLA).

REQUIRED PER 33.07 = 7 OVERSTORY TREES (2.465 SF BUILDING / 2000 = 2, OR 720 LF STE PERMETER / 100 = 7)

REQUIRED PER 32.54 = 4 OVERSTORY TREES (ADDITIONAL - 1.5X WITHIN HWY 65 OVERLAY DISTRICT)

1074. REQUIRED = 11 OVERSTORY TREES

EROUS TREES.

CONFERONS TREES (2,465 SF BUILDING / 2000 = 2, OR 720 LF STE
PERMITTER / 200 = 4)

CONFERONS TREES (2,465 SF BUILDING / 2000 = 2, OR 720 LF STE
PERMITTER / 200 = 4)

CONFERONS TREES (ADDITIONAL - 1.5X WITHIN HWY 65 OVERLAY DISTRICT)
DIAL PROVIDED = 6 CONFERONS TREES
CONFERONS TREES (ADDITIONAL - 1.5X WITHIN HWY 65 OVERLAY DISTRICT)
DIAL PROVIDED = 6 CONFERONS TREES (ADDITIONAL - 1.5X WITHIN HWY 65 OVERLAY DISTRICT)
DIAL PROVIDED = 6 CONFERONS TREES (ADDITIONAL - 1.5X WITHIN HWY 65 OVERLAY DISTRICT)
DIAL PROVIDED = 6 CONFERONS TREES (ADDITIONAL - 1.5X WITHIN HWY

AMENTAL TREES.

8COURED FOR 3.507 = 4 ORNAMENTAL TREES (2.465 SF BUILDING / 2000 = 2, OR 720 LF STE
PERMETER / 200 = 9

101A_ROUBED = 6 ORNAMENTAL TREES (ADITIONAL = 1.5K WITHIN HWY 65 OVERLAY DISTRICT)
101A_ROUBED = 6 ORNAMENTAL TREES

I. OVERSTORY TREES.

1. OVERSTORY TREES (3.292 SF BUILDING / 2000 = 2, OR 758 LF STE FERMETER / 100 = 8)

1. SCOUNDED FOR 32.54 = 4 OVERSTORY TREES (4.00100MAL = 1.5X WITHIN HWY 65 OVERLAY DISTRICT)

1. DECEMBER 1. SCOUNDER 1. OVERSTORY TREES (1.0010MAL = 1.5X WITHIN HWY 65 OVERLAY DISTRICT)

1. SCOUNDER 1. SCOUNDER 1. OVERSTORY TREES (1.0010MAL = 1.5X WITHIN HWY 65 OVERLAY DISTRICT)

EROUS TREES.

8COURD PER 33.07 = 4 CONFEROUS TREES (3,292 SF BUILDING / 2000 = 2, OR 758 LF STE

9ERMETER / 200 = 4)

101A RQUIRD = 6 CONFEROUS TREES (ADDITIONAL = 1.5X WITHIN HWY 65 OVERLAY DISTRICT)

101A PROVIDED = 6 CONFEROUS TREES (ADDITIONAL = 1.5X WITHIN HWY 65 OVERLAY DISTRICT)

RSTORY SHUBS.

8COURED FR 33.07 = 25 UNDERSTORY SHRUBS (3.292 SF BUILDING / 300 = 11, OR 758 LF SITE FERMETER / 30 = 25)

8COURSED FER 32.54 = 13 UNDERSTORY SHRUBS (ADDITIONAL - 1.5X WITHIN HWY 65 OVERLAY DISTRICT 1074, EXQUIRED = 30 UNDERSTORY SHRUBS (ADDITIONAL - 1.5X WITHIN HWY 65 OVERLAY DISTRICT 1074, EXQUIRED = 140 UNDERSTORY SHRUBS

ORNAMENTAL TRES.

SCURRID FER 33.07 4 ORNAMENTAL TREES (3.392 SF BUILDING / 2000 = 2, OR 758 LF SITE FEMALER / 2000 = 4)

SCURRID FER 32.54 = 2 ORNAMENTAL TREES (ADDITIONAL = 1.5X WHINI HWY 65 OVERLAY DISTRICT) 1074. PROVIDED = 6 ORNAMENTAL TREES

- REFERENCE SPECIFICATIONS. THE FOLLOWING SPECIFICATIONS SHALL GOVERN THIS PROJECT ACCORDING TO THE VANING GROER:

 1. ADDENDA, WITH THOSE OF A LATER DATE HAVING PRECEDENCE OVER THOSE OF AN EARLIER DATE.
 2. LANGSCAPE SPECIFICATIONS.
 3. PLAN DRAWNS.
 - PLAN DRAWINGS.
 PLANT / MATERIAL SCHEDULES.
 CITY STANDARD SPECIFICATIONS AND DETAILS.
 MODOT STANDARD SPECIFICATIONS FOR CONSTRUCTION, LATEST EDITION.







CARLSON

PLAN

LANDSCAPE

ADDITION SQUARE SECOND Blaine, Minnesota


BLAINE


ESTATE, reet, Suite 26 MN 55402 . REAL I CAPITAL F 60 South S Minne


EVISIONS







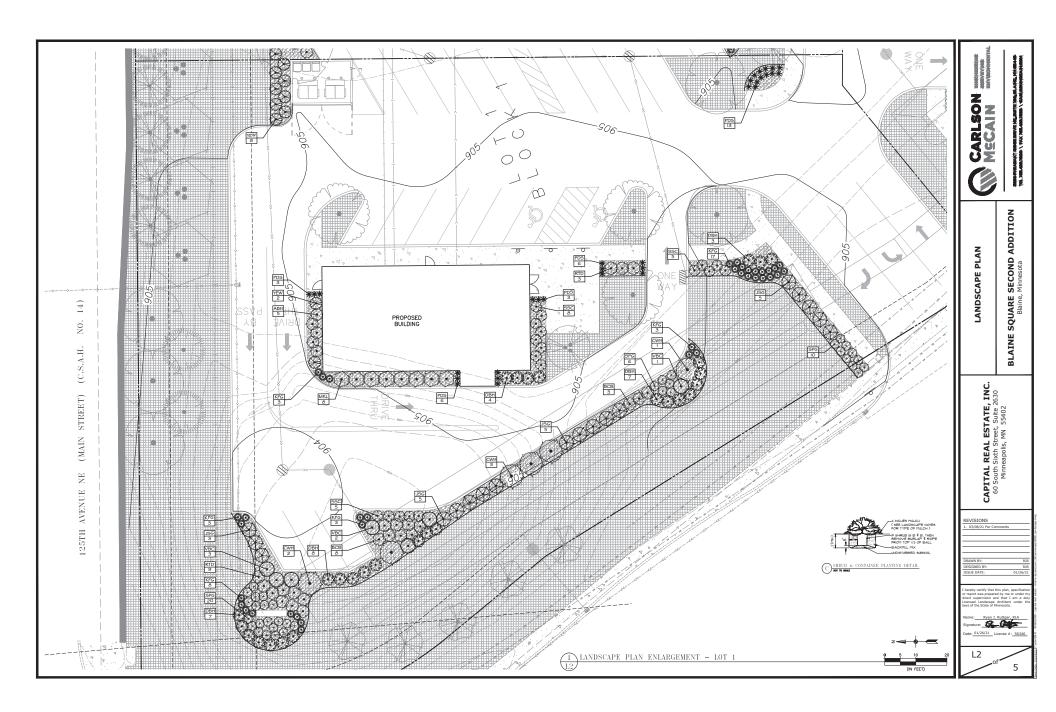

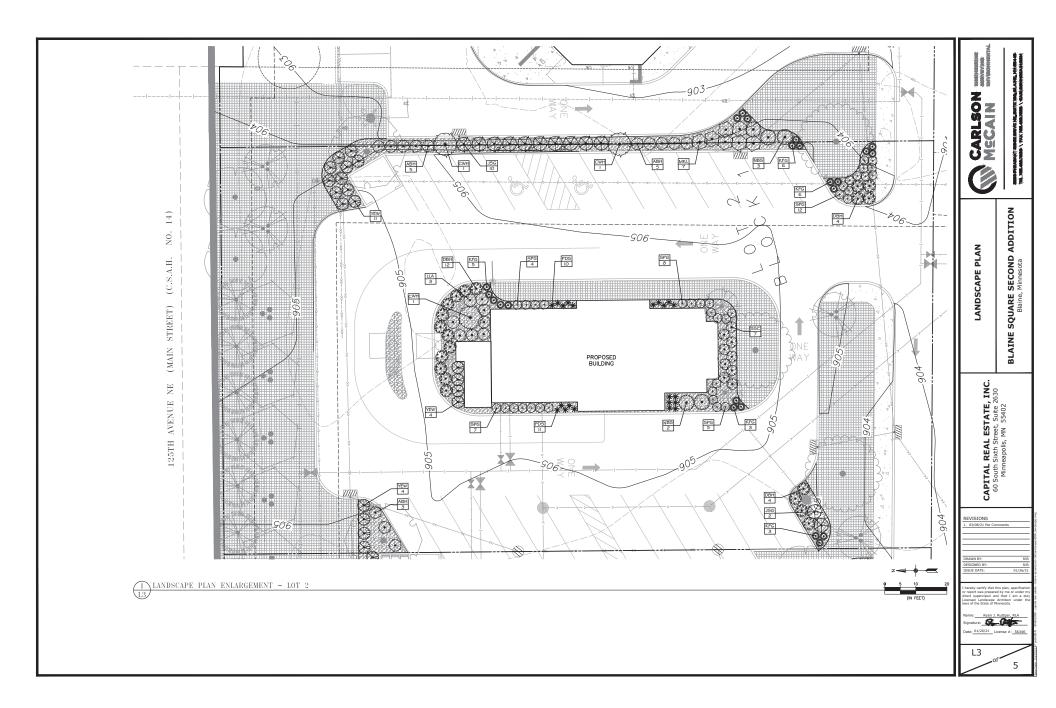

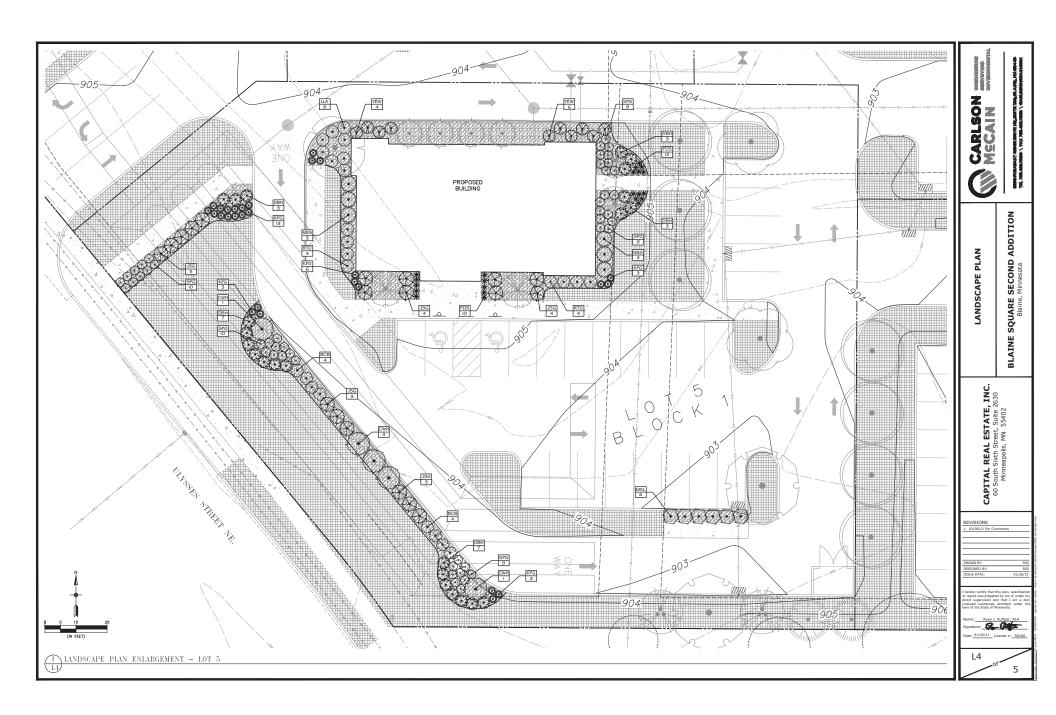

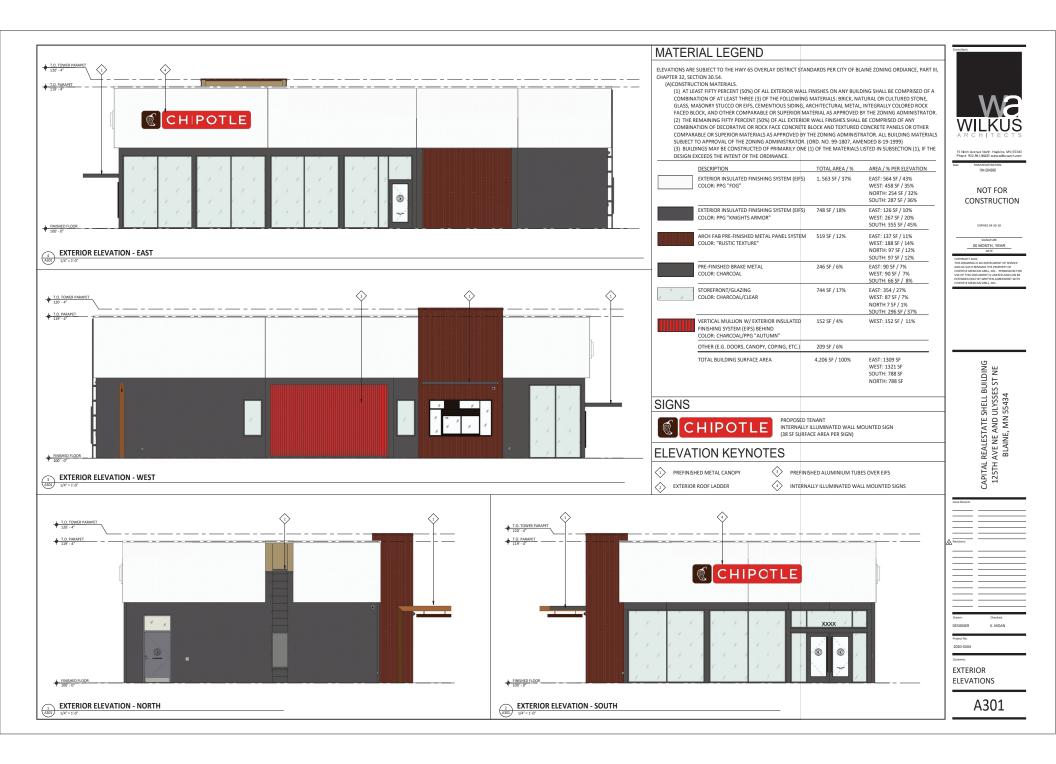

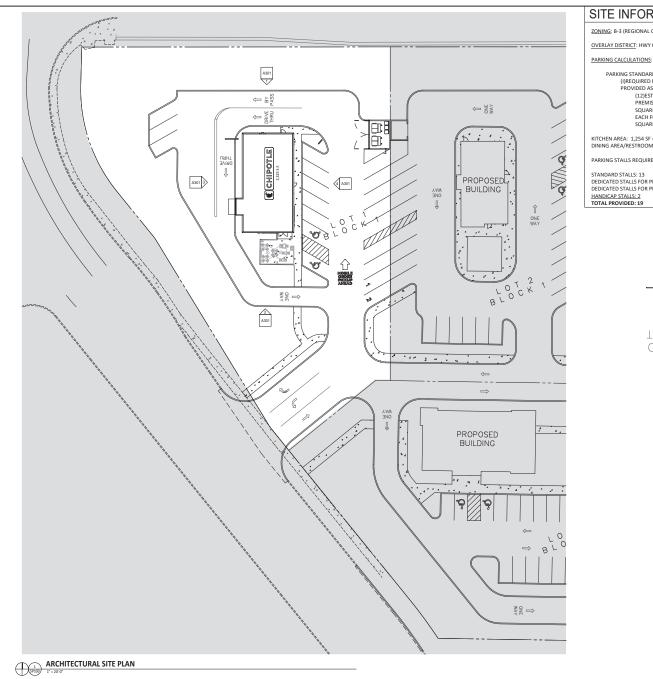

SITE INFORMATION

ZONING: B-3 (REGIONAL COMMERCIAL)

OVERLAY DISTRICT: HWY 65 OVERLAY DISTRICT (HOD)

PARKING STANDARDS PER CITY OF BLAINE ZONING ORDINANCE, PART III, CHAPTER 33, SECTION 33.13. (I)REQUIRED PARKING SPACES. OFF-STREET PARKING SPACES ACCESSORY TO DESIGNATED USES SHALL BE PROVIDED AS FOLLOWS:

(12)ESTABLISHMENTS HANDLING THE SALE AND CONSUMPTION OF FOOD AND REFRESHMENT ON THE PREMISES INCLUDING EVENT CENTERS: AT LEAST ONE (1) PARKING SPACE FOR EACH ONE HUNDRED (100) SQUARE FEET OF FLOOR AREA, EXCLUDING BAR AREA AND KITCHEN AREA, ONE (1) PARKING SPACE FOR EACH FORTY (40) SQUARE FEET OF BAR AREA AND ONE (1) PARKING SPACE FOR EACH TWO HUNDRED SQUARE FEET OF KITCHEN AREA.

RESTROOMS

0000

DINING

KITCHEN AREA: 1,254 SF = (1 PARKING SPACE PER 200 SF) = 1,254/200 = 7 PARKING SPACES
DINING AREA/RESTROOMS: 1,071 SF = (1 PARKING SPACE PER 100 SF) = 1,071/100 = 11 PARKING SPACES

X .

KITCHEN

PARKING STALLS REQUIRED: 18

STANDARD STALLS: 13 DEDICATED STALLS FOR PICK-UP ORDERS: 2 DEDICATED STALLS FOR PULL-AHEAD PARKING: 2



NOT FOR CONSTRUCTION

PITAL REALESTATE SHELL BUILDING 125TH AVE NE AND ULYSSES ST NE BLAINE, MN 55434


	CA 1
Issue Record:	
A Revisions:	
Drawn:	Checked:
DESIGNER	K. MOAN

ARCHITECTURAL SITE PLAN

SP100

TENANT REFERENCE PLAN

1/8" = 1'-0"

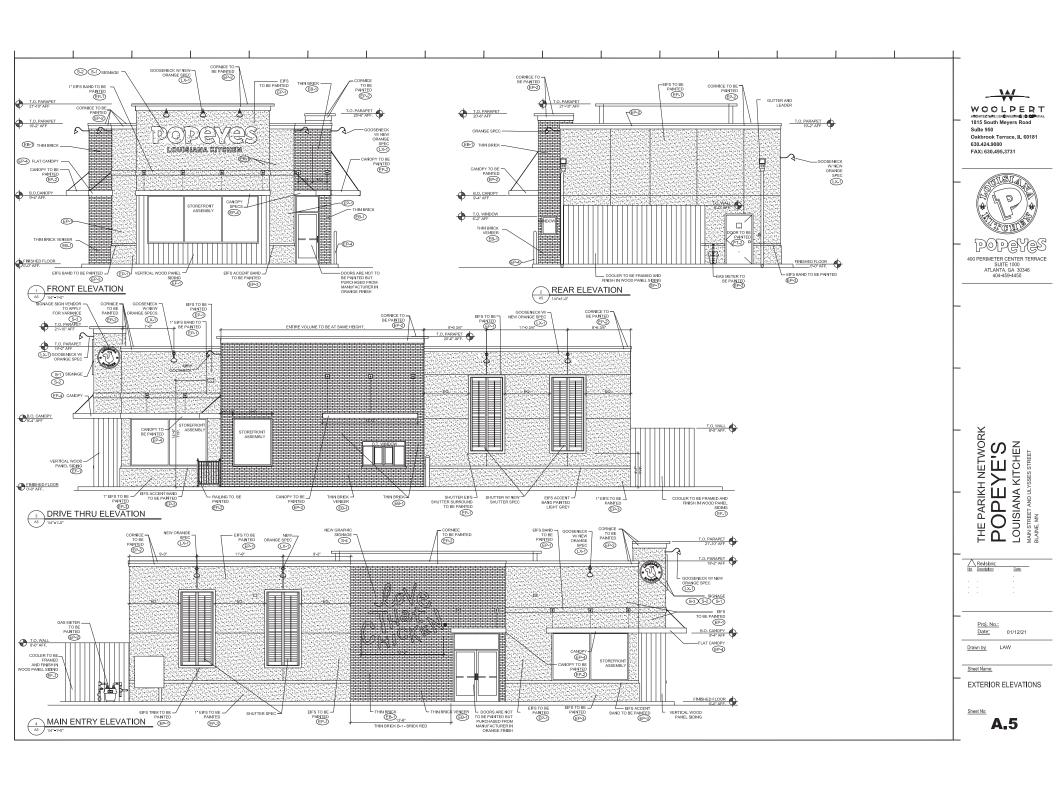

				POPEYES LOUISIANA KI			
				EXTERIOR MATERIALS & FINISH SCHEDULE (not all specs are used on every project)		
10/19 CODE	MATERIAL	LOCATION	MANUFACTURER		DESCRIPTION		ADDITIONAL INFORMATION
				PRODUCT	COLOR	DIMENSION	
EP-1	EXTERIOR PAINT	MAIN WALL SURFACE ABOVE WAINSCOT ACCENT TRIM		PRIMER: PAINT:	"WHITE" OC-125 Moonlight White		Contect: RODGER LIPPMAN, ARCHITECTURAL ACCOUNT EXECUTIVE phone: (800) 344-0400 Ext 5240
				PRIMERI	"BLACK"	+	email: rodger.lippman@benjaminmoore.com
EP-2	EXTERIOR PAINT	PARAPET TRIM	BENJAMIN MOORE	PAINT	2120-20 Black Eron		
EP-3	EXTERIOR PAINT	WAINSCOT ACCENT TRIM AND BELOW	DERDAMIN PROJEC	PAINTI	"GRAY" HC-170 Stonington Grey		
EP-4	EXTERIOR PAINT	BOLLARDS, PYLON POLE AND DIRECTIONAL SIGN POLES		PRIMER: PAINT:	"RED" 2096-10 Excitic Red		
EP-5	METAL/PAINT	DRIVE THRU WINDOW CANOPY		PRIMER: Pro Industrial Pro-Cryl Primer B66-310 PAINT: Pro Industrial High Performance Acrylic B66-660 Eggahell	FACTORY FINISH BLACK		
EP-7	EXTERIOR PAINT	DUMSPTER WALLS		PAINT:	*GRAY* HC-170 Storlington Grey		
EP-7	EXTERIOR PAINT	DUMSPTER SATES	BENJAMIN MODRE	PRINER: Pro Industrial Pro-Cryl Primer B56-310 PAINT: Pro Industrial High Performance Acrylic B56-600 Gloss	FACTORY FINISH BLACK		
EP-8	EXTERIOR PAINT	ALL EXTERIOR WALLS		PAINT: Allphatic Acrylic Urethane Clear Gloss	ANTI-GRAFFITI PAINT M74-00 / M75 2 COATS ON FULL FAÇADE SURFACE		
EF-1	WOODEN SIDING PANEL	EXTERIOR WALLS	NICHIHA	VINTAGE WOOD	CEDAR		
EB-1	BRICK	EXTERIOR TOWERS	DESIGN AND DIRECT SOURCE	ARCHITECTURAL URBAN SERIES	FLAGSTAFF		

AND THE PRIMALE INQUINEERING INCOMPANIAL 1815 South Meyers Road Sulte 950
Oakbrook Terrace, IL 60181
630.424.9080
FAX: 630.495.3731



THE PARIKH NETWORK POPEYE'S LOUISIANA KITCHEN MANN STREET AND ULYSSES STREET BLAINE, MN
Revisions: His Describes Date:
 -

Proj. No.: Date: 01/12/21


Drawn by: LAW

Sheet Name:

EXTERIOR FINISH & LIGHT FIXTURE SCHEDULE Sheet No:

A.5.1

POPEYES LOUISIANA KITCHEN - LIGHTING INTERIOR AND EXTERIOR FIXTURE SCHEDULE (not all spacs are used on every project)								
12/10/2019				1		,		
EXTERIOR FIXTURES								
TYPE		LOCATION	MANUFACTURER	CATALOG NUMBER	COLOR TEMP	WATTAGE	ADDITIONAL INFORMATION	
LX-1		EXTERIOR WALL	HERMITAGE	MODEL: H-HLPP82A3Y044L FINISH: CUSTOM COLOR ORANGE 4000 LUMENS	LED2, 3500K	38W		
LX-2		FLAT CANOPY	HERMITAGE	MODEL: E-CONOLIGHT &E-CP2L04CS 36 LED MODULES/ 4100 LUMENS	COOL WHITE 5000K	42W LED		

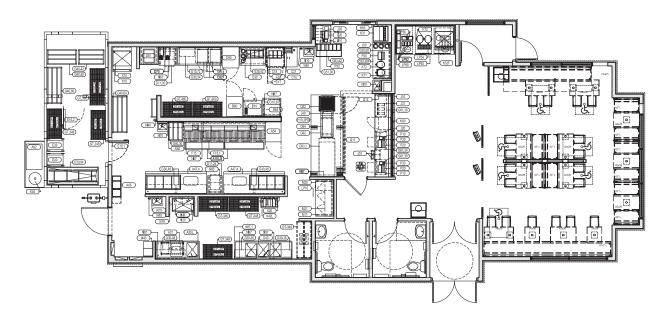



WOOLPERT
ARCHITECTURE | ENGINEERING | BESERVIAL
1815 South Meyers Road
Sulte 950

Oakbrook Terrace, IL 60181 630.424.9080 FAX: 630.495.3731



POPCYS

400 PERIMETER CENTER TERRACE
SUITE 1000
ATLANTA, GA 30346
404-459-4450

THE PARIKH NETWORK
POPEYE'S
LOUISIANA KITCHEN
MAN STREET AND ULYSSES STREET
BLANE. AN

Revisions:

No. Describers Date:


Proj. No.: Date: 01/12/21

Drawn by: LAW

Sheet Name: FLOOR PLAN

Sheet No:

A.1

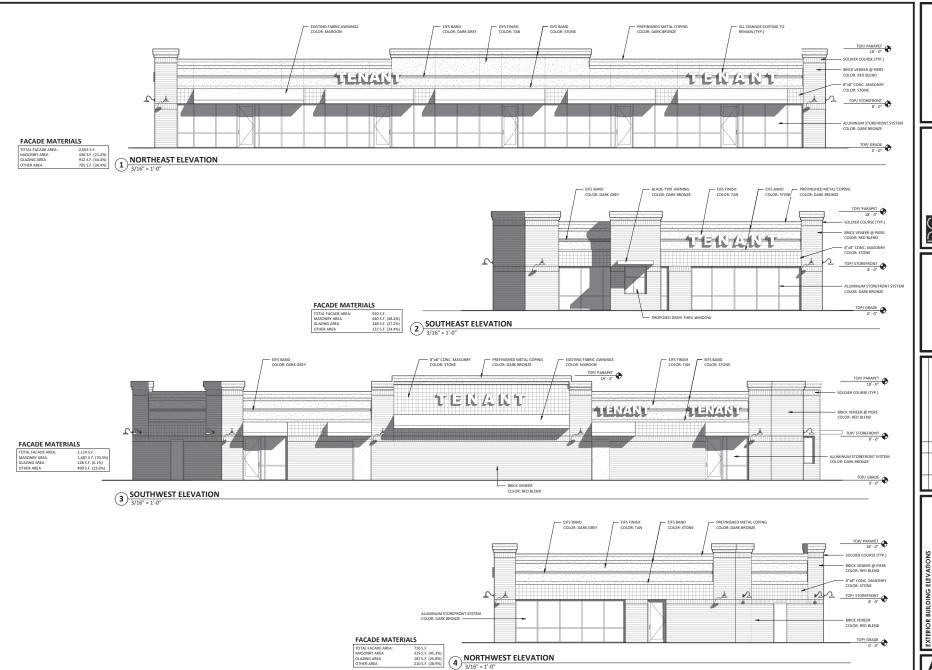

BLAINE SQUARE LLC SOUTH BIST, THEN

DG PArchitecture 1220 N. North Earth St. 206 (773)904-8891

D DATE BY REVISIONS

NG ELEVATIONS


EXISTING RETAIL

CENTER
12421 Usses 51 NE
Bione, MN 55424

DRAWN BY: SD EXIS

REVIEWED: DGP 12.2

A-210

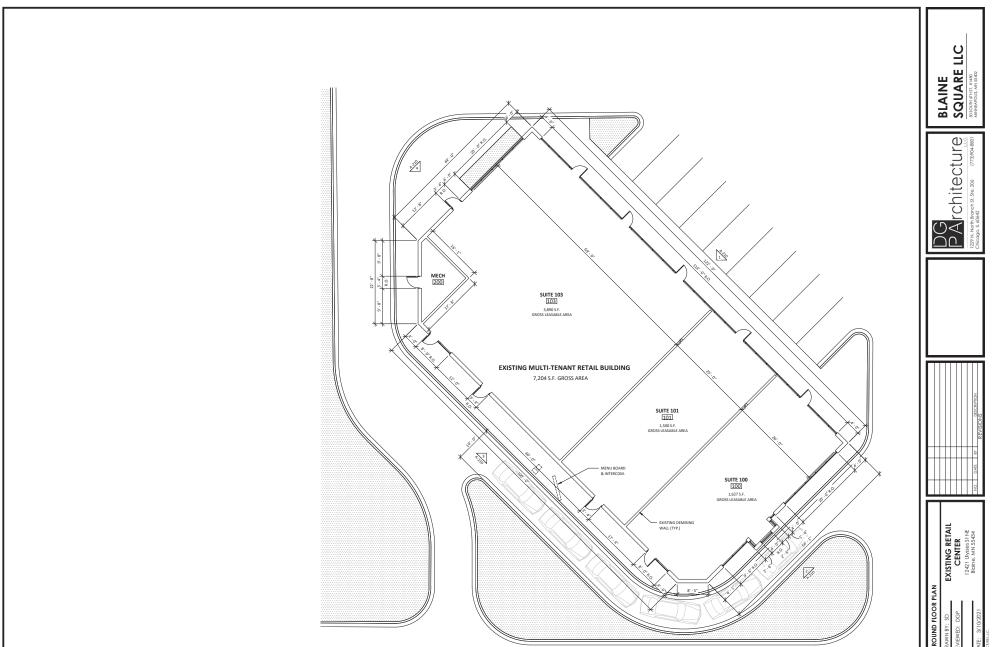

GROUND FLOOR PLAN

1/8" = 1'-0"

EXISTING RETAIL
CENTER
12421 Uysses St NE
Bigine, MN 55434



Lot 3 Northeast Elevation




Lot 3 Southeast Elevation



Lot 3 Southwest Elevation



Lot 3 Northwest Elevation

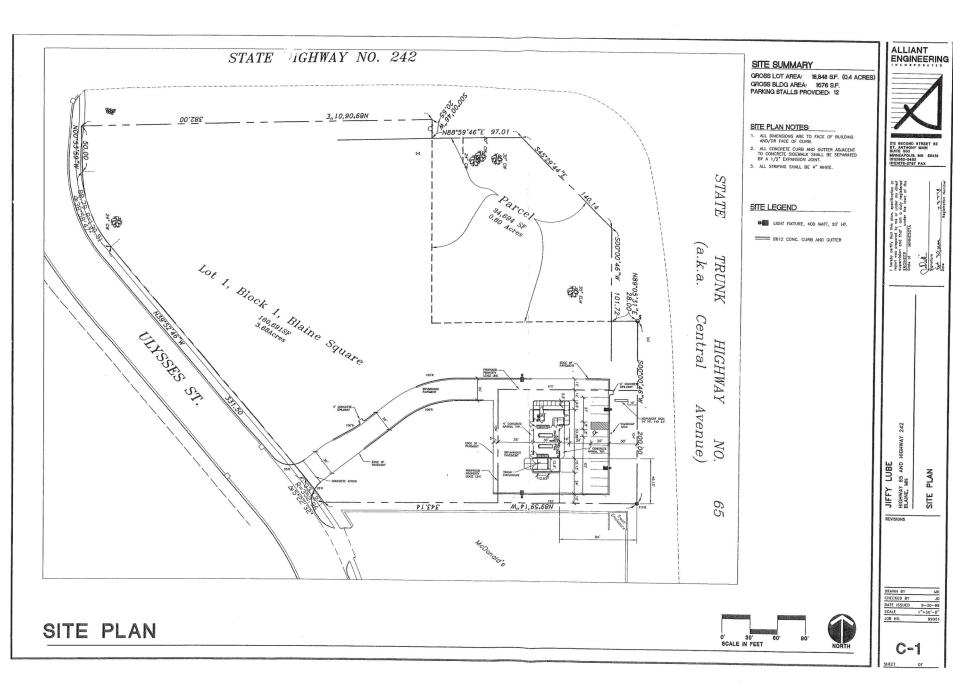



Lot 4 East Elevation



Lot 4 West Elevation



Lot 4 North Elevation



Lot 4 South Elevation