




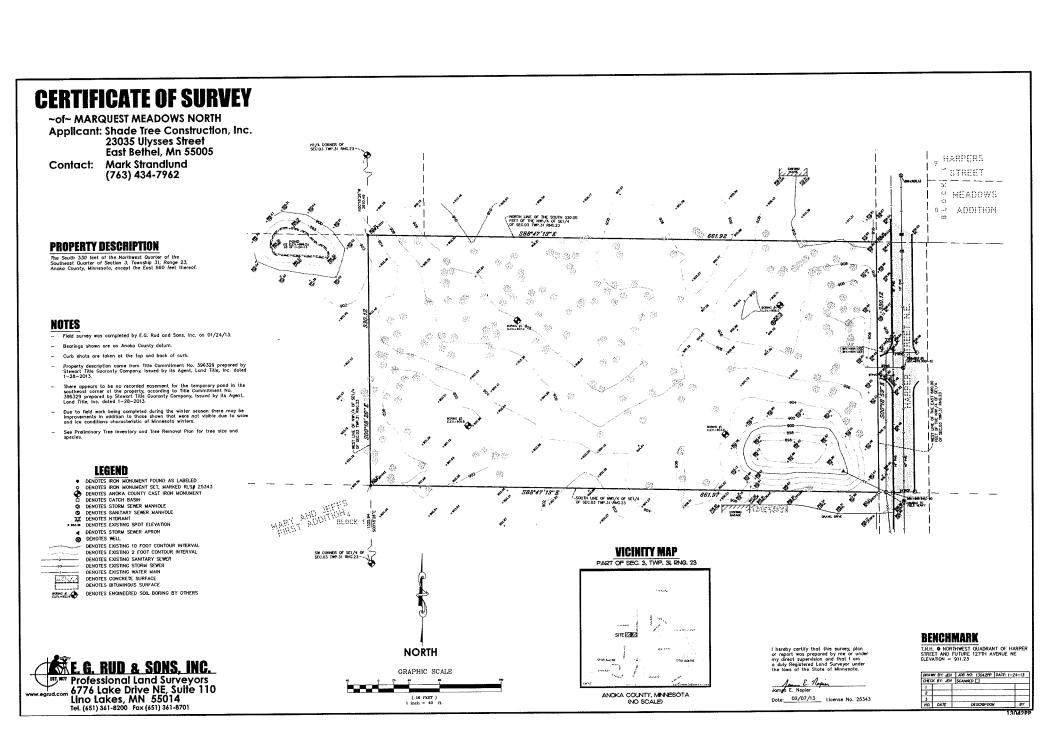

**Case File No. 13-0013** 

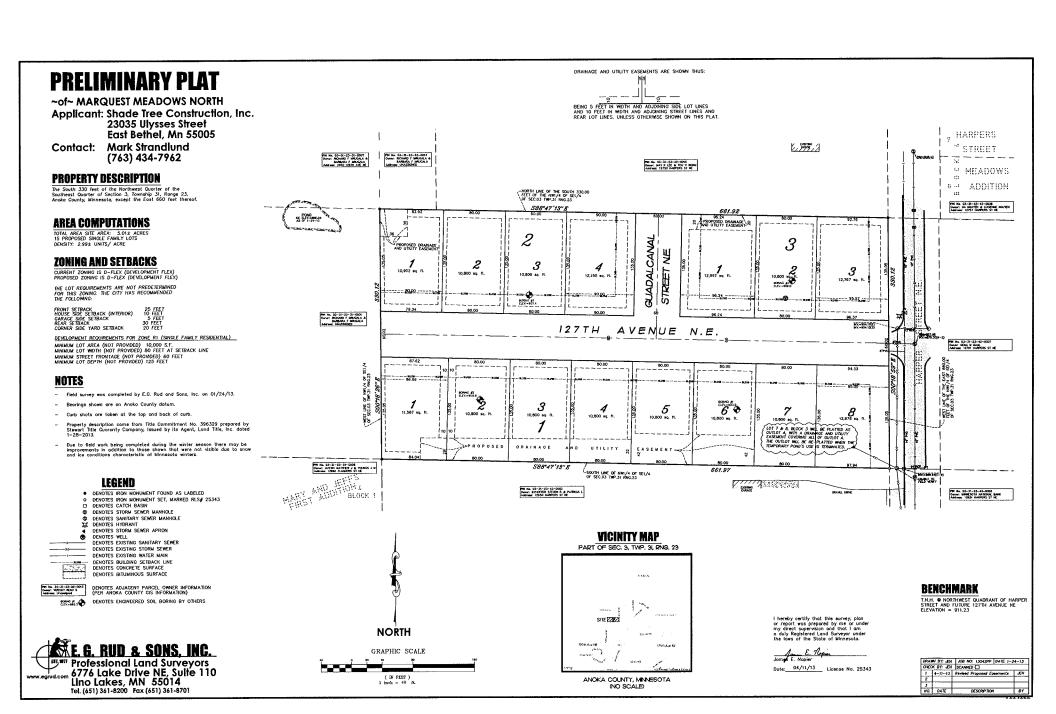

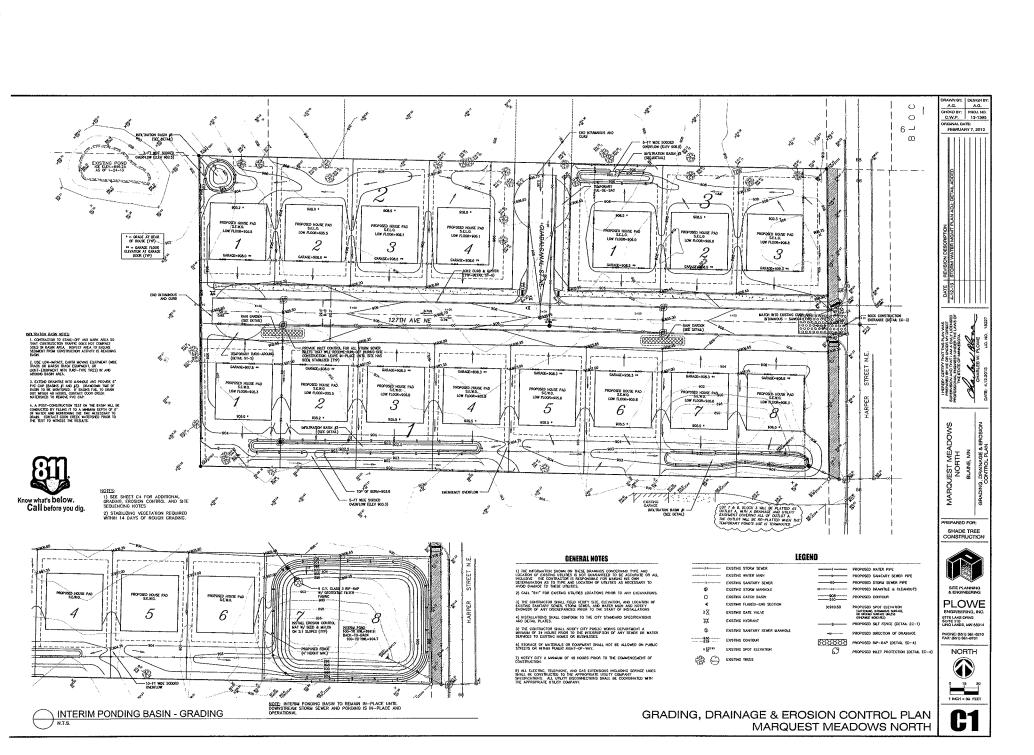



## **OVERALL CONCEPT PLAN**

~for~ SHADE TREE CONSTRUCTION, INC. ~of~ 12700 HARPERS STREET NE

### **PROPERTY DESCRIPTION**

The south 330 feet of the Northwest Quarter of the Southeast Quarter of Section 3, Township 31, Range 23, except the east 660 feet thereof, except road, located in Ancko, County, Minnesota.

#### **ZONING AND SETBACKS**

CURRENT ZONING IS D-FLEX (DEVELOPMENT FLEX) PROPOSED ZONING IS D-FLEX (DEVELOPMENT FLEX)

THE LOT REQUIREMENTS ARE NOT PREDETERMINED FOR THIS ZONING. THE CITY HAS RECOMMENDED THE FOLLOWING:

FRONT SETBACK HOUSE SIDE SETBACK (INTERIOR) HOUSE SIDE SETBACK (CORNER) REAR SETBACK

<u>QEVELOPMENT REQUIREMENTS FOR ZONE RI (SNGRE FAMILY RESDENTIAL)</u>

HANBIJM LOT AREA (NOT PROVIDED) 10,000 S.F.

HANBIJM LOT WOTH (NOT PROVIDED) 80 FEET AT SETBACK LINE

HANBIJM LOT DEPTH (NOT PROVIDED) 60 FEET

HANBIJM LOT DEPTH (NOT PROVIDED) 125 FEET


#### **VICINITY MAP**

PART OF SEC. 3, TWP. 3I, RNG. 23



ANOKA COUNTY, MINNESOTA (NO SCALE)

GRAPHIC SCALE ( DI FEET ) 1 inch = 60 ft.

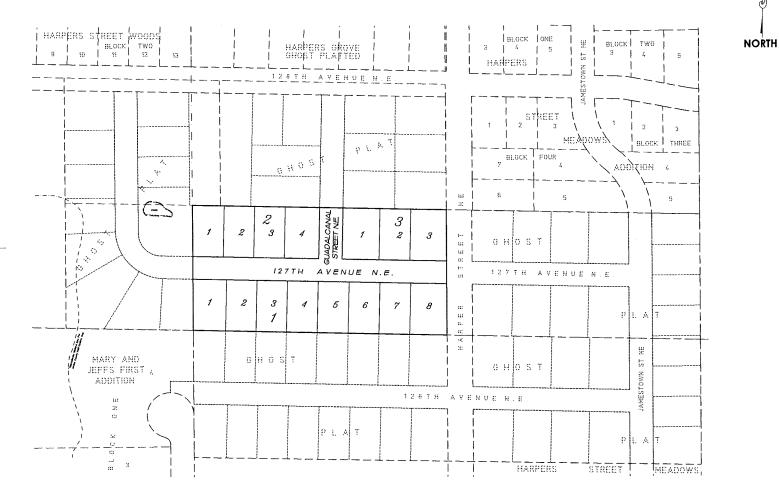

E.G. RUD & SONS, INC. Professional Land Surveyors 6776 Lake Drive NE, Suite 110 Lino Lakes, MN 55014 Tel. (651) 361-8200 Fax (651) 361-8701

# PRELIMINARY TREE INVENTORY AND TREE REMOVAL PLAN

~of~ MARQUEST MEADOWS NORTH

Applicant: Shade Tree Construction, Inc.


23035 Ulysses Street East Bethel, Mn 55005

Contact: Mark Strandlund

(763) 434-7962

#### VICINITY MAP

PART OF SEC. 3, TWP. 3I, RNG. 23

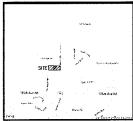

ANOKA COUNTY, MINNESOTA

#### TREE NOTES

- Field survey was completed by E.G. Rud and Sons, Inc. on 01/24/13.
- Trees shown ore 8 inches in diameter or larger.

#### LEGEND

- DENOTES CATCH BASIN
  DENOTES STORM SEWER MANHOLE
  DENOTES SANITARY SEWER MANHOLE
  SEMENT SHORMAT
  DENOTES HYDRANT
  DENOTES EXISTING SPOT ELEVATION

- DENOTES STORM SEWER APRON
  DENOTES WELL
- - DENOTES EXISTING 10 FOOT CONTOUR INTERVAL DENOTES EXISTING 2 FOOT CONTOUR INTERVAL

  - DENOTES EXISTING SANITARY SEWER DENOTES EXISTING STORM SEWER

  - DENOTES EXISTING WATER MAIN
- DENOTES CONCRETE SURFACE DENOTES BITUMINOUS SURFACE
- M DENOTES PROPOSED TREE REMOVAL



<u>eegend</u> 10° = tree size 2 = romber of trees			TREE INVENTORY LIST				IREE COUNT TOTAL OVERSTORY DECOUGUS SHADE TREES - 200 TREES TO BE REMOVED TREES - 172 TREES TO REMAIN - 28			
TREE NO.	TREE TYPE AND SIZE	TREE NO.	TREE TYPE AND SIZE	TREE NO.	TREE TYPE AND SIZE	TREE NO.	TREE TYPE AND SIZE	TREE NO.	TREE TYPE AND SIZE	
1109	OAK 14"	1156	MAPLE 10°	1213	OAK 11"	1268	0AK 13"	1331	POPLAR 11"	
1110	OAK 11"	1157	OAK 19"	1214	OAK 11°	1269	OAK B*	1332	POPLAR 9"	
3111	OAX 12"2	1160	POP 11"	1215	0AK 10*	1270	OAK 9"-2	1333	POPLAR 9*	
1112	OAK 12"-2	1161	PDP 11"	1216	OAK 10"	1271	DAK 10"	1334	POPLAR 9"	
1113	0AK 12*	1163	OAK 8	1217	OAK 17"	1272	GAK 9'	1335	OAK 13	
1114	OAX 9"	1164	OAK 21	1218	OAK 13*	1273	OAK 11"	1336	POPLAR 9" POPLAR 12"	
1115	CAX 8"	1165	OAK 10*	1219	OAK 12*	1274	OAK B"	1337	POPLAR 10	
1116	OAK B*	1166	OAK 10"	1220	OAK 8" OAK 14"-2	1278	OAK 13"	1338	POPLAR 9"	
1117	OAK 18"	1167	BCHERRY 10"	1221	OAK 11 -2	1280	OAK 14"	1340	ELM 11	
1118	0AX 18	1169	OAK 9*	1222	OAK 10*	1281	OAK 14"	1341	POPLAR 8	
1120	OAK 18"	1175	0AK 21"	1224	0AK 8*	1282	0AK 16"-2	1342	POPLAR 8"	
1121	OAX 15	1177	0AK 17"	1225	OAK 11°	1283	OAK 8'	1343	POPLAR B*	
1122	OAK 15"	1178	OAK 8°	1226	OAK 12*	1284	OAK 15"	1344	POPLAR 11"	
1123	OAK 11"	1179	OAK 13*	1227	OAK 20	1285	OAK 12*	1345	POPLAR 8"	
1124	OAK 14"	1180	OAK 9°	1231	OAK 9°	1286	OAK 12"	1351	POPLAR 11"	
1125	OAX 12"	1181	OAK 13"-2	1232	OAK 17"	1287	OAK B"	1352	OAX 9"	
1126	OAK 23*	1182	OAK 12"	1254	OAK 15"	1288	OAK 12"	1353	OAK 10"	
1127	OAK 13"	1183	OAK 17"	1241	OAK 8*	1289	OAK 26"	1355	OAX 17"	
1128	0AK 20"	1184	OAK 15"	1242	OAK 9"	1298	OAK 28"	1357	POPLAR 8"	
1129	OAK 16*	1385	0AK 10*	1245	OAK 15"	1292	OAK 13*-2	1		
1130	OAK 8"	1186	0AK 12*	1246	OAK 11"	1293	QAK 13*			
1131	0AK 17"	1187	0AK 14"	1247	OAK 9*-2	1294	OAK 24*	1	ì	
1132	OAK 10"-2	1158	OAK 16"	1248	OAK 11"	1295	OAK 15"	1		
1133	OAK 14"	1189	0AK 11*	1249	OAK 12"	1296	OAK 10"	1		
1134	OAK 12" HOLLOW	1190	0AK 9*	1250	OAK 14"	1297	OAK 10*	1		
1135	OAK 18"	1191	BCHERRY 8*	1252	OAK 15"	1298	0AK 13"	1		
1136	0AK 13"	1192	BCHERRY 8"	1253	OAK 20*	1299	OAK 12"	1 1		
1137	DAK 22"	1193	BCHERRY 9"	1254	BCHERRY B*	1300	0AK 15"	1		
1138	OAK 14"	1194	BCHERRY 8"	1255	OAK 10*	1301	0AK 12" 0AK 15"			
	OAK 14*	1195	0AK 10	1256	OAK 13"	1302	CAK 18"	1		
1141	0AK 14"	1196	0AK 19"~2	1257	0AK 15	1303	0AK 10"	1		
1143	0W 12,	1197	0AK 10"	1259	0AK 10*	1306	OAK 9"	1 1		
1144	0AK 16*	1205	0AK 12"	1260	OAK 13-2*	1307	0AK 16"	1		
1145	OAK 12*	1200	DAK 9"	1261	0AK 10"	1315	HAPLE 9'	1 1		
1146	0AK 10*	1207	DAK 8"	1262	0AK 15"	1316	POPLAR 9"	1 1	1	
1147	0AX 17*	1208	0AK 16"	1283	0AK 13"	1317	0AX 8"	1 1		
1148	0AK 11*	1209	OAK 9"-2	1264	0AK 16"	1318	BIRCH 9*	1		
1153	DAX 12"	1210	0AK 13*	1265	OAK 13*	1319	BARCH 5	1		
1154	DAX 12"	1211	0AK 12"	1268	0AK 13*	1329	OAK 9"	1		
1155	0AX 9"	1212	0AX 8"	1267	0AK 9*	1330	POPLAR 9"	1		

AVENUE

Luni

777772255

×

NEW YEAR

#### **BENCHMARK**

T.N.H. © NORTHWEST QUADRANT OF HARPER STREET AND FUTURE 127TH AVENUE NE ELEVATION = 911.23

I hereby certify that this survey, plan or report was prepared by me or under my direct supervision and that I am a duly Registered Land Surveyor under the laws of the State of Minnesota.

Dote: 04/11/13 License No. 25343

		JOB NO: 13042PP	DAILE: 1-	29-13
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,	4-11-13	odditional tree remo	100	,EN
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NO.	DATE	DESCRIPTION		87

## E.G. RUD & SONS, INC. **Professional Land Surveyors** 6776 Lake Drive NE, Suite 110 Lino Lakes, MN 55014


Tel. (651) 361-8200 Fax (651) 361-8701



BEFORE FINAL ELECRICAL INSPECTION

CLEAN AREA OF ALL CONSTRUCTION DEBRIS

EGRESS WINDOWS REQUIRED IN EACH BEDROOM AND BASEMENT

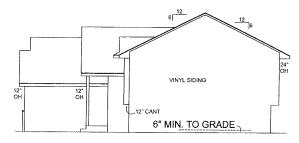

**RIGHT ELEVATION** 

SCALE:1/8"=1'-0"

NO OCCUPANCY CERTIFICATE PRIOR TO WATER METER AND REMOTE INSTALLATION

220# ASPHALT SHINGLES ROOF VENTS AS REQTO @ 1 S.F. PER 200 S.F. AREA П VINYL SIDING

REAR ELEVATION

SCALE:1/8"=1'-0"

BUYER NOTICE:

PLE TO THE VARIOUS SHE CONSTITIONS OF NOW YOU WILLIAMS OF COMPETENCES FOR FORD 

SIDERS:(FLASHING NOTE)

- ALL OFENNOS TO EXTENT VIBT DE CALVED E FLASFED. - FLASFRYSTIS DECURED WHEE ALL FORK AND VIETKAL NUFFAZES MEET, OR WHERE STONIS MATERIAL OWNIGES

> ALUMNAM SOFFIT VENU SIGNED

> > #15 FELT ON FIBERBOARD SHEATHING BEFORE BRICK, VENEER OR CEDAR/REDWOOD

FRONT ELEVATION

Ø

HOUSE NUMBERS REQUIRED DO NOT INSTALL ON GARAGE DOOR

#### ENERGY CODE NOTE:

CONTRACTOR AND SUB-CONTRACTORS ARE RESPONSIBLE FOR COMPLIANCE OF THE CURRENT CODE AS REQUIRED

HOME TO BE BUILT TO ALL CATAGORY 1 REQUIREMENTS INCLUDING BUT NOT LIMITED TO THE FOLLOWING.

- INTERIOR VAPOR RETARDER ON INSULATED CEILINGS, WALLS & FLOORS.
   CONTINUOUS AIR BARRIER AT ALL PLUMBING
- AND HEATING PENETRATIONS.

  3.FIRE STOPS MUST BE INSTALLED TO BLOCK AIR MOVEMENT INTO ATTIC.
- MOVEMENT IN OATHIC.

  4. PENETRATIONS IN THE BUILDING ENVELOPE
  FOR ELECTRICAL AND TELECOMMUNICATIONS
  EQUIPMENT (EXCEPT FOR ELECTRICAL BOXES
  AND FAN HOUSINGS) MUST BE SEALED TO
  PREVENT AIR LEAKAGE.
- 5. WIND WASH BARRIER REQUIRED AT THE

: 18 (F 712 PKG) - WM 6 (2 RKG)

- EXTERIOR EDGE OF ATTIC INSULATION.

  6. WIND WASH BARRIER REQ'D AT OVERHANGS.
- SUCH AS CANTILEVERED FLOORS & BAYS.

  7. WINDOW AND DOOR FRAMES MUST BE SEALED.

  8. ALL EXTERIOR JOINTS THAT MAY BE A SOURCE
- 8 ALL EXTERIOR JOIN IS THAT MAY BE A SOURCE OF AIR INTRUSION MUST BE SEALED 9. RIM JOISTS MUST BE SEALED TO PREVENT AIR LEAKAGE. 10. TOPS OF INTERIOR PARTITION WALLS MUST BE SEALED TO PREVENT AIR LEAKAGE 11. ELECTRICAL BOXES AND FANS MUST BE SEALED TOPPOLY AND AND THAT SOURCE SOURCE.
- TO PREVENT AIR LEAKAGE.

  12. BETWEEN WALL ASSEMBLIES, RIM JOISTS AND
- FOUNDATIONS MUST BE SEALED TO PREVENT AIR LEAKAGE

#### ADDITIONAL CODE REQUIREMENTS INCLUDE:

- 1. A MECHANICAL VENTALATION SYSTEM WHICH REPLACES BY DIRECT OR INDIRECT MEANS AIR FROM HABITABLE ROOMS WITH OUTDOOR AIR FROM MABITABLE ROOMS WITH OUTDOOR AIR
  (THIS WOULD ALLOW EXHAUST ONLY, AIR EXCHANGER,
  OR HEAT RECOVERY VENTILATOR.
  2 DIRECT VENTI, POWER VENTI, OR SEALED COMBUSTION
  FURNACE, WATER HEATER, OR GAS FIREPLACE.
  3 IF ANY SINGLE EXHAUST DEVISE (E.G. KITCHEN FAN,
  OR DRYER) OVER 300 CPMIS INSTALLED, A SEALED
  (COMBISTION BIBMACE MISTED FOR DAME)
- COMBUSTION FURNACE MUST BE USED OR AN ALTERNATIVE MAKE UP AIR SOURCE MUST BE USED.


ELEVATIONS NOTED 07AUG12 BY: SCALE


608 129TH LANE BLAINE, MN. 55434 LOT # 17 BLOCK #1 SHADE TREE COVE

DORT OF THE CASAGOR ON EXPONENTIVE CONTINUED WERE ON CONSISTENT ST. OF PANKS WRITE DORT OF THE REST OF MA AULTONIC CONTINUED WAS DECEMBED. ALL OF BLUESCHOOL OF BLUESCHOOL

PLAN NUMBER 035 - 12

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DRAWN BY: SAR SCALE: AS NOTED DATE: 27SEP712

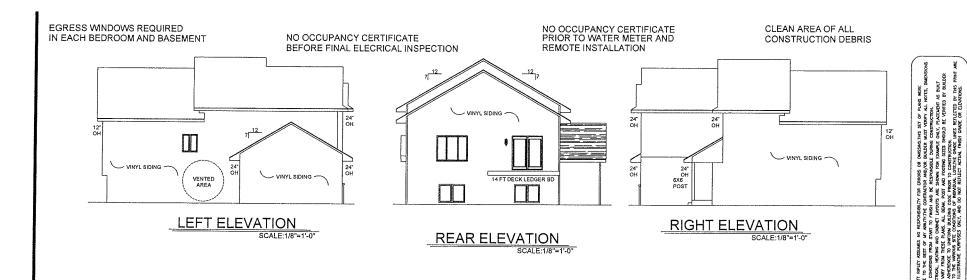PRODUCT NAME & ADDRESS.
12941 MADISON & ANNE CARDA
12941 MADISON ST NE
BLANN MN. 55434
LOT #1 BLOCK #3
SHADE TREE COVE OF BLANE

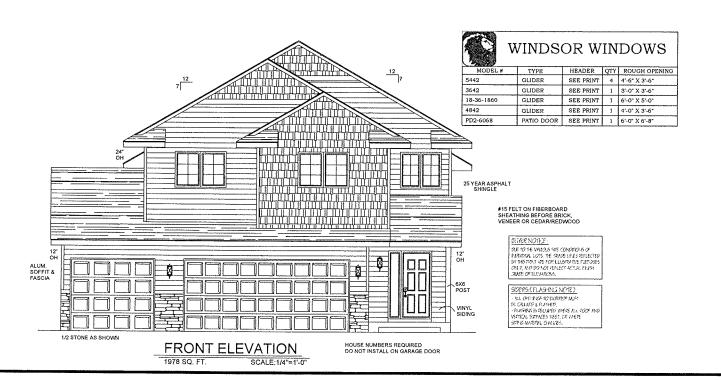
OF 5

PLAN NUMBER

042 - 12

EXTERIOR ELEVATIONS

653-130tb Lane NE

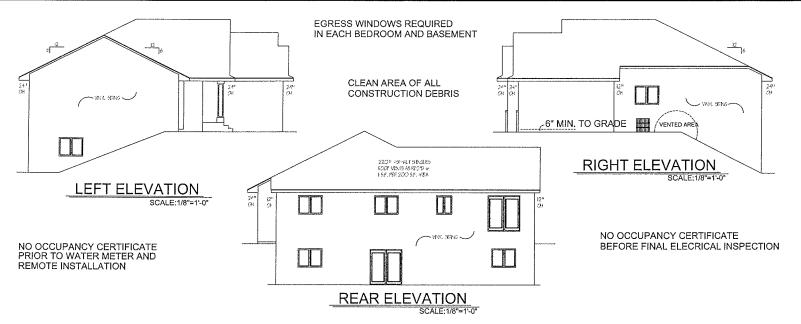



PROJECT NAME & ADDRESS
VINCENT THAO
VINCENT THAO
VINCENT THAO
LOT 4800 BLOCK #P
SHADE TREE COVE 3RD AD

ALMINEY SOTH \$ FA9CIA Ø WILL 9016

HOUSE NUMBERS REQUIRED DO NOT INSTALL ON GARAGE DOOR

## WINDSOR WINDOWS

MODEL#	TYPE	HEADER	QTY	ROUGH OPENING
5442	GLIDER	SEE PRINT	6	4'-6" X 3'-6"
3642	GLIDER	SEE PRINT	1	3'-0" X 3'-6"
18-36-1854	GLIDER	SEE PRINT	1	6'-0" X 4'-6"
PD2-6068	PATIO DOOR	SEE PRINT	2	6'-0" X 6'-8"

BLAYER NOTICE: DIE 10 DE WAKAB SIE CONDIDORS CH RONDUM, LOTS, DE CRADE JNES PETLECTES SY SHO PRINT ARE FOR LUIDWANTAE FLIPPOSE

SIDERS (FLASHING NOTE) - AL OFENASS TO EXERCI MED SE CALLED E R.-GED. - IL AGRIG DISCOLED WESE AL, EOCH AND ONLY, AND DO NOT BEFLECT ACTUAL FINDS DANTE OR ELEVATIONS. VERTICAL SUPPLIES LIKET OF WHERE STONG LAMBERAL COVEREDS.

> #15 FELT ON FIBERBOARD SHEATHING BEFORE BRICK, VENEER OR CEDAR/REDWOOD


FRONT ELEVATION 2591 SQ. FT.

SCALE:1/4"=1'-0"


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> SHEET 1 OF 4

PLAN NUMBER 016 - 11 CLEAN AREA OF ALL CONSTRUCTION DEBRIS

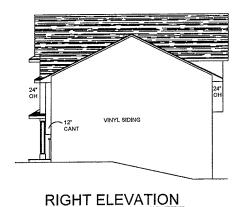


NO OCCUPANCY CERTIFICATE
BEFORE FINAL ELECRICAL INSPECTION

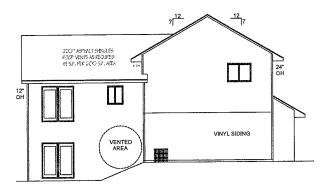

REAR ELEVATION
SCALE:1/8"=1'-0"

EGRESS WINDOWS REQUIRED IN EACH BEDROOM AND BASEMENT

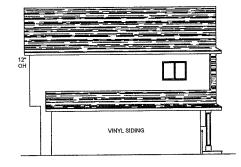

LEFT ELEVATION

SCALE:1/8"=1'-0"


EXTERIOR ELEVATIONS
DRAWN BY: SAR
SCALE. AS NOTED
DATE: OBMAR12


BRIAN CHRISTENSON 12991 VAN BUREN ST. BLAINE, MN. 55434

BIGHT SEARCH TO RESIDENCE OF CHARACTER OF PARAMETERS OF PARAMETERS OF PARAMETERS OF THE PARAMETERS OF

94651 1 OF 5

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ARCHTECTURAL SHINGLES

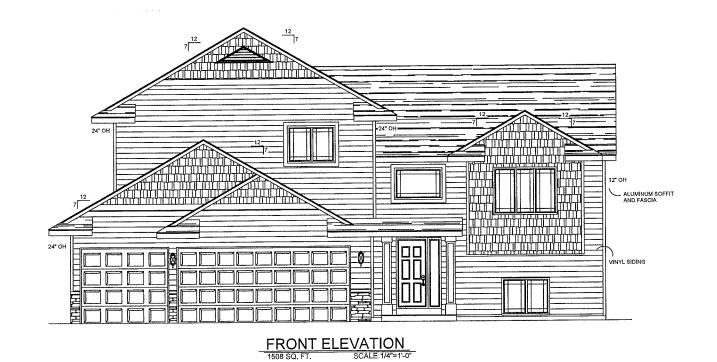ARCHTECTURAL SHINGLES

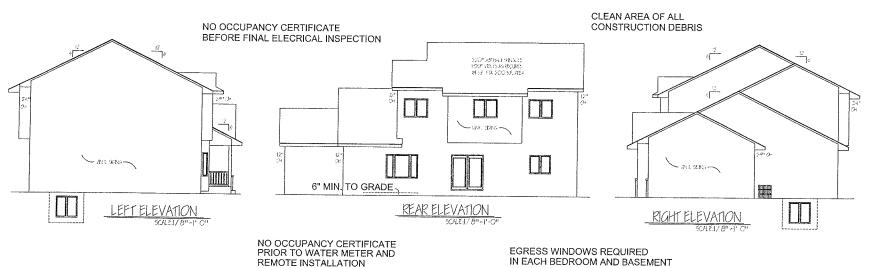ALUM SOFFIT A FASCIA
VINYL SIDING

WOOD PGRGH

FRONT ELEVATION

PROJECT NAME & ADDRESS
JUSTIN & ELIZABETH KAPPEL
700 1291H LN NE
BLANE, MN. 55434
LOT # BLOCK #

ELEVATIONS

EXTERIOR ELEY
DRAWN BY: SAR
SCALE: AS NOTED
DATE: 01NOV11

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